

Prevent • Promote • Protect


Environmental Health Division

1675 W. Garden of the Gods Rd., Suite 2044 Colorado Springs, CO 80907 (719) 578-3199 phone

(719) 578-3188 fax www.elpasocountvhealth.org

ON-SIJE WASTEWATER SYSTEM INSPECTIO	ON FORIVI	PERIMIT :	# <u> 9N 003278</u> 7
_/ _	1	DAT	E July 18,2013
APPROVED YES NO Environmental Health Sp	pecialist: J. Christen	sen	
Address: 12840 Blue Spruce Ln 80908	Owner Andrew M	€nq	
Legal Description: Lot 4. Blue Spruce Est		- J	
Residence / #Bedrooms A Commercial System in		xcavatir	7 9
SEPTIC TANK: Construction Material Concrete		1500 + 12	150 with pun
DISPOSAL FIELD:		in 2nd	chamber
Trench: Depth (Range) Width	Total Length	Sq. Ft	
Bed: Depth (Range) Width			
Depth of Rock Under PVC Typ	e of cover on Rock		
DRYWELLS: # of Pits Rings(Pit 1) Rings(Pit2)	Working Depth #	1	#2
Size (L x W) #1 #2	Total Sq. Ft		
ROCKLESS SYSTEMS: Law - pressure drip			
Standard Chamber: Type #Chambers	Sq. Ft./Chamber	Bed	Trench
High Profile Units: Type #Chambers	Sq. Ft./Chamber	Bed	Trench
Reduction Allowed % Sq. Ft. Required	Depth (Range)		
Sq. Ft. Installed 3000 Equivalent Sq. Ft. Installed	with Reduction N/A		
Engineer Design: YN N□ Engineering Firm <u>Geoguest</u>	Appro	oval Letter Provid	ed: Y 📝 N 🗌
Well installed at time of septic inspection: Y☑ N□ Public Water: Y□	⊒ NE⊠		
*Approval will be revoked if in the future the well is found to be within 50 fe	et of the septic tank and/or 100	feet of the dispos	al field.
Notes: Risers installed on septic tanks:	1' and 3'12 ' c.sp	~ an fice	+ tank
3/2 risers on 2 nd tank	4 2000 2 7/30	<i>Ch 1113</i>	/ Junk,
· ·	,, ,		
End sweeps had not been instal	14d en laterals.		
			
Z			

· Well

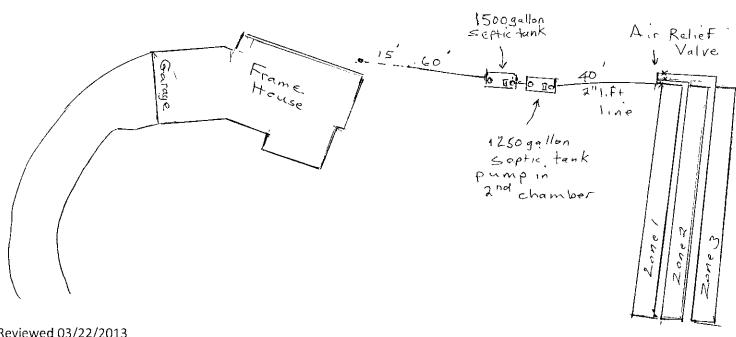

Reviewed 03/22/2013

Blue Spruce In.

Notify Environmental Health of any change of ownership, type of business activity, business name, or billing address by calling (719) 578-3199. Failure to notify Environmental Health may result in late penalties, Permit/License denial or revocation, and business closure. PERMITS/LICENSES TO OPERATE AND ANNUAL FEE PAYMENTS ARE NOT TRANSFERABLE. Permits become void on change of ownership. New owners must apply and pay for a new Permit(s)/License(s) prior to beginning operation.

Attn: ANDREW H MENG 12840 BLUE SPRUCE LN

COLORADO SPRINGS, CO. 80908



EL PASO COUNTY PUBLIC HEALTH ENVIRONMENTAL HEALTH DIVISION

1675 W. GARDEN OF THE GODS ROAD, SUITE 2044 **COLORADO SPRINGS, CO 80907** PHONE: (719) 578-3199 FAX: (719) 578-3188 www.elpasocountyhealth.org

NEW SYSTEM PERMIT - OWTS

Valid From 12/31/2012 To 12/31/2013

PERMITEE .

OWNER NAME:

ANDREW H MENG 12840 BLUE SPRUCE LN COLORADO SPRINGS, CO 80908

ANDREW H MENG

Onsite ID: ON0032787

Tax Schedule #: 5211001011 Permit Issue Date: 12/26/2012

Dwelling Type: RESIDENTIAL

of Bedrooms (if Res): 4 Proposed Use (if Comm):

Designed Gallons/Day:

Water Source: PRIVATE WELL

System Installation Requirements:

Dues to bedrock at 30 inches an engineer design septic shall be installed at this site.

Install system per attached design project #12-0561 in area of soil percolation test.

A profile pit inspection is required by the engineer prior to installation of STA.

Health Dept. shall inspect system prior to backfill.

An engineer approval letter must be received by this office for final approval of system.

Septic Tank Capacity Required: 1500

(Gallons)

Soil Treatment Area Required: 3000

The Health Officer shall assume no responsibility in case of failure or inadequacy of an Onsite Wastewater Treatment System, beyond consulting in good faith with the property owner or representative. Access to the property shall be authorized at reasonable time for the purpose of making such inspections as are necessary to determine compliance with the requirements of this law (permit)

Installer inspection request line: Call (719) 575-8699 before 8:30 a.m. of the day that the inspection is requested Weekends & Holidays excluded.

This permit is issued in accordance with 25-10-106 Colorado Revised Statutes. The PERMIT EXPIRES upon completion/installation of the Onsite Wastewater Treatment System, or at the end of twelve (12) months from date of issue, whichever occurs first. If both a Building Permit and an Onsite Wastewater Treatment System Permit are issued for the same property and construction has not commenced prior to the expiration date of the Building Permit, the Onsite Wastewater Permit shall expire at the same time as the Building Permit. This permit is revocable if all stated requirements are not met. Onsite Wastewater Treatment System to be installed by an El Paso County Licensed System Contractor, or the property owner.

Authorized By: Environmental Health Specialist



Prevent • Promote • Protect

1675 W. Garden of the Gods Rd., Suite 2044 Colorado Springs, CO 80907 (719) 578-3199 phone (719) 578-3188 fax www.elpasocountyhealth.org

APPLICATION FOR AN ON-SITE WASTEWATER TREATMENT SYSTEM PERMIT
NEW PERMIT MAJOR REPAIR PERMIT MINOR REPAIR PERMIT
Owner Andrew H Meng Daytime Phone 719 332-4419 1020
System Installer Hazelton Exc. Daytime Phone 719 237-3677
Property Address 12840 Blue Spruce Ln. Lot 4 C.S CO 80908. Starl
Owners Mailing Address 2664 Glen Arbor Dr.
Email Address Fax #
Tax Schedule # 52110 - 01 - 011 Lot Size 5.16 Acres
Site Located Inside City Limits Yes No Primary Contact Owner Contractor
Proposed Use: Single Family Multi-Family Commercial
Water Supply: Well Cistern Municipal Number of Bedrooms 4 Pickup: Email: Steve Overholser@hotmail:
Ricksup: Email: Steve Overholser@hotmail
CURRENT FEES AS APPROVED BY THE ELPASO COUNTY BOARD OF HEALTH
New Permit: \$440.00 (EPCPH Charge) + \$147.00 (EPC Planning Dept. Surcharge) + \$23.00 (CDPHE Surcharge) = \$610.00
Major Repair Permit: \$494.00 (EPCPH Charge) + \$23.00 (CDPHE Surcharge) = \$517.00
Minor Repair Permit: \$188.00 (EPCPH Charge) + \$23.00 (CDPHE Surcharge) = \$211.00 • All Payments are due at the time of application submittal; by cash, check or major credit card (Visa / MC)
This permit will expire one year from the date of issuance.
I certify that the information provided on this application is in compliance with Section 8.3, Chapter 8 of the Onsite Wastewater System (OWS) Regulations of the El
Paso County Board of Health. I also authorize the assigned representative of El Paso County Public Health to enter onto this property in order to obtain information necessary for the issuance of a permit.
Applicants Signature: Date: 12-24-12
Site Insp. Date: Dcc, 27, 12 Perc. Rate: 18,9 Permit # 0 N D03 2 787
E.H.S. Review Notes: Ground was trozen and Snow covered
Dec 500 0 1 10 2/12 51 101 15 15 15 15 15 15 15 15 15 15 15 15 15
Date to: E.P.C. Development Services 222612 Flood Plain and Enumerations 22512
Permit Requirements: Due to bedrock @ 30" an engineer design septic shall be
installed at this site. Install system por attached design project # 12-0561 in area of soil percolation test. A profile pit
inspection is required by the engineer prior to installation
of STA. · Health Dapt. Shall Inspect System prior to
packfull an engineer approval letter must be recould
Min. Septic Tank Capacity Min. Absorption Area
E.H. Specialist Jane Architecture Date 12-31-12 Approved Denied
mailer pumit 12/20/12 PF
ynimens povino 12/2012 PT

1)	We require an original copy of your <u>PERCOLATION TEST</u> with a licensed engineer's (P	'.E.)
	stamp and signature as well as a plot plan of the test hole locations with measurements fro	m a
	fixed reference point.	

2) Pi	roperty address or lot number must be posted	d and clearly visible	* . · · ·	tion
ho	oles must be clearly marked or an additional	charge for a return	COUNTY FIERLTH DEPARTMENT	sed.
3) Ą	plot plan must be drawn on an 8 1/2" x 11" s	heet of paper and s		ms:
/ a)	North Arrow e) Proposed S	eptic System Site	12-36-2142 WE 174	ıtion
− b)	Property Lines 1) Alternate Se	eptic System Site		ty
/ c)	Property Dimensions (g) Driveway &	Name of Adjoinir	:1170	
✓d)	All Existing and Street · · · ·	, , , ,	(联) [4] (五) [5]	
	Proposed Buildings	. ;	OW DATE THE 187 OF	
	,			*
4) Ad	lditional items that shall be included on the	plot plan if they ap	NBIL 319.9. GROV 610.00	
✓a)	Proposed &/or Existing Wells	٠.	URUS SENSO	
b)	Wells on Adjacent Properties	e) Drainage Wa		
c)	Water Lines	(ie: Streams, I	HAND NATUE DAY	
ď)	Bodies of water (ie: Lake, Pond)	f) Subsoil Drain		

5) Please provide below complete and accurate directions to the property from a main highway.

North on Hwy 83

Eart on Shoop Rd.

North on Blue Spruce Ln.



6825 Silver Fonds Heights #101 Colorado Springs, CO 80908 (719) 481-4560

PERCOLATION TEST

FOR

TIFFANY HOMES

JOB #12-0561

Lot 4,
Blue Spruce Estates Subdivision,
12840 Blue Spruce Lane,
El Paso County,
Colorado

Respectfully submitted,

Charles E. Milligan, P.E.

Civil Engineer

Due to encountering bedrock (sandstone at the depth of 30 inches the county health department will require the septic system to be installed on this site to be designed by a Colorado Licensed Engineer.

Enclosed are the results of the percolation test for the septic system to be installed at Lot 4, Blue Spruce Estates Subdivision, 12840 Blue Spruce Lane, El Paso County, Colorado. The locations of the percolation test borings were determined by Steve Overholser. The residence will not be on a public water system. The number of bedrooms in the design for the residence is unknown. Due to the natural slope of the property, the entire system will feed to the north-northeast at 3% approximately 125 feet. All applicable regulations of the El Paso County Health Department ISDS Regulations must be complied with for the installation of the disposal system.

The percolation test was performed on September 5, 2012, in accordance with **Section 8.6, Soil Test, E.P.C.P.H.OWS Regulations.** The field data and results of the percolation test are as follows:

PERC.	PERC HOLE #1	PERC HOLE #2	PERC HOLE #3
TEST	@ 34" DEPTH	@ 34" DEPTH	@ 34" DEPTH
@ TIME	DROP (IN	DROP (IN	DROP (IN
	INCHES)	INCHES)	INCHES)
2:00	7-1/2	6	9-1/16
2:10	5-5/16	3-1/2	1-15/16
2:20	2-1/2	2-1/8	1-3/4
2:30	1-1/2	1-1/2	1-3/8
2:40	1/2	7/8	7/8
2:50	3/8	1/2	1
Rate/Hole	26.7	20.0	10.0

The average of the test holes is 18.9 minutes per inch.

Blow counts at the depth of 3 feet was 44/12.

The soil profile for the disposal system is as follows:

- 0 to 6" Topsoil- loam, organic composition.
- 6" to 30" Sand- fine to coarse grain, moderate density, low moisture content, low clay content, low plasticity, light brown in color.
- 30" to 10' Sandstone- fine to coarse grain, high density, low moisture content, low clay content, low plasticity, buff in color.

No water was encountered during the drilling of all holes. Bedrock (sandstone) was encountered at the depth of 30" during the drilling of the test borings. No known wells were observed within 100 feet of the proposed system. All setbacks shall conform to county regulations.

GEOQUEST LLC

SITE MAP

Lot 4,

Blue Spruce Estates Subdivision, 12840 Blue Spruce Lane, El Paso County, Colorado, Job 12-0561

Profile \P1

 \sim TH-2

TH-1-0

Location to Profile from Northeast Lot Corner:

S.50' W. - 165' Location from Profile to:

P1: S. 25° E. – 4' P2: N. ~ 18' P3: N. 6° W. – 24'

GPS Coordinates: N. 39', 01', 08.61" W. 104', 38', 36.41"

25 50 75 100 CRAPHIC SCALE IN FEET SCALE: 1" - 100'

Blue Spruce



DEVELOPMENT SERVICES DEPARTMENT


SEPTIC SITE REVIEW

DATE: December 31, 2012
File#: SEP-12-137 Property Address: 12840 BLUE SPRUCE LN Tax Schedule # 52110-01-011
Legal Description: <u>LOT 4 BLUE SPRUCE ESTATES</u>
Lot Area: <u>5.16 ACRES</u> District: <u>RR-5</u>
Subdivision Plat #: 11221 Book: _ Page: Recorded Date: 07/29/2002
Reception #: 202122453
APPROVED DISAPPROVED BY: Cathy Spaulding
PLAT NOTES/REMARKS:

This form is intended solely as a checklist to forewarn builder/landowner of potential development problems. Plat information and general remarks may affect development and should be noted. Prior to issuance of a building permit, final plot plan approval is required.

Any approval given by El Paso County does not obviate the need to comply with applicable Federal, State or Local laws and/or regulations.

WWW, ELPASOCO.COM

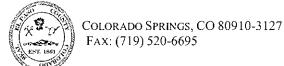

From: Amy Vanderbeek Sent: December 27, 2012 To: Health Department Subject: Septic Review

SEPTIC REVIEW FORM

Parcel Schedule Number: 52110-01-011

Legal Description: Lot 4 Blue Spruce Estates

Address: 12840 Blue Spruce Lane

Approved: 12-27-12/Amy Vanderbeek

Enumerations Comments: Per Platted address

Floodplain Approved: 12-28-12/AV

Floodplain Comments: Per Flood Insurance Rate Map No. 08041C0325F, effective date March

17, 1997. Zone X. Community No. 080059 0325F

POSTED

Floodplain & Enumerations SR

1. 12840 Blee Sprice

2. 11

CALCULATIONS:

Soil Treatment Area Design:

4 Bedrooms

Perc Rate 18.9 MiN/IN

Average Daily Flow (Q) = 4 Bedrooms * 150 = 600 GPD

Max. Soil Loading Rate (R) = 0.4634 GPD / SF

A = (Q/R)(1.5)(1.6)(1.17)(0.75) = 2,726.8 SF (Use 3,000 SF)

Septic Tank and Plumbing Design:

Number of Laterals:

3,000 SF / 200 SF per Lateral = 15 Laterals

(500 LF per Zone)(3 Zones) = 1,500 LF of Pipe

Pump: Use Zoeller "Mighty Mate" 53, Orenco Pl3005 High Head Effluent Pump, or Approved Equivalent; Design Flow Rate = 20.0 GPM Total Dynamic Head (TDH) = 10.9 ft to Valve Manifold Dose Vol. = 300 Gal. Recommended

Main Septic Tank Size: Min. 1,500 GAL Pump Chamber: Min. 500 GAL

Distribution Pipe: Use 2" Ø Class 200 PVC Field (Zone) Pipe: Use 2" Ø Class 200 PVC 1/4" Ø Holes @ 8" O.C.

* Geoguest, LLC. Percolation Test Locations Location from Northeast Lot Corner to Profile: S. 50° W. - 165' Location from Profile to:

P-1: S. 25° E. - 4' P-2: Due N. - 18' P-3: N. 6° W. - 24'

GPS Coordinates: N. 39° 01' 8.61", W. 104° 38' 36.41"


Geoguest, LLC. has Provided this Design in Accordance with the Standards of Practice Common to the Area. However, as with All Underground Absorption Fields, Guarantee from Failure is Impossible. Even with Proper Installation, as Outlined for this Proposed Construction, There Can Remain Many Uncertainties, and Difficulties Can Still Arise in the Operation of the System in the Future. Proper Design, Construction, and Maintenance can Assist in Minimizing Uncertainties, but Cannot Entirely Eliminate Them. Homeowners Should be Advised of Maintenance and Special Considerations for Septic Systems. Geoquest, LLC. Provides No Warranty of this Design or Installation.

All Bends Limited to 45 Degree Ells or Long Sweep Quarter Bends. Areas Under Driveways Shall Be Protected as Per El Paso County Health Department Regulations.

Building Sewer Clean-Outs Shall Be Installed within 5 FT of the Structure and at Intervals Not to Exceed 100' in Straight Runs and When the Cumulative Change in Direction Exceeds 135 Degrees.

Location of Septic Tanks to be Field Determined (Min. 10 FT from the House).

Site Plan Prepared from Incomplete Data. Verify All Locations Prior to Excavation. Location of Driveway Must be Verified on Site when Built / Installed.

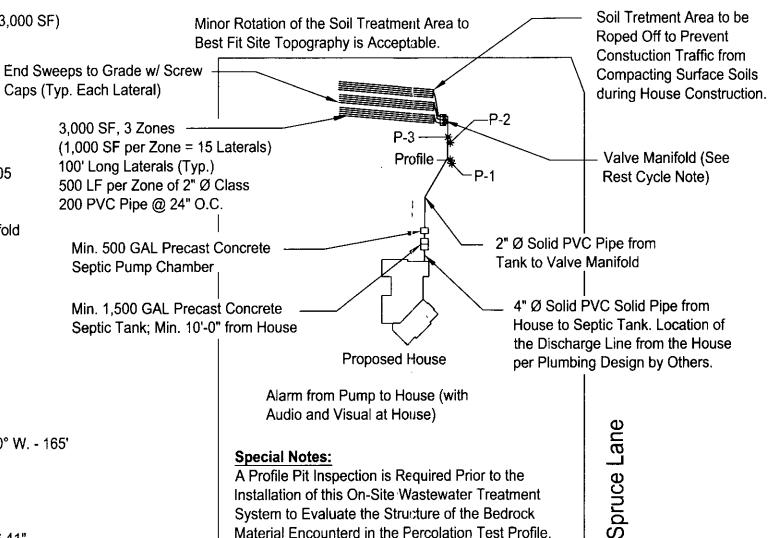

Special Notes:

A Profile Pit Inspection is Required Prior to the Installation of this On-Site Wastewater Treatment System to Evaluate the Structure of the Bedrock Material Encounterd in the Percolation Test Profile.

Location of Well Unknown, Maintain a Minimum Horizontal Distance of 100 ft between the Well and the Soil Treatment Area.

Blue

INSPECTIONS REQUIRED ARE AS FOLLOWS:

- 1.) Engineer to Verify Soil Treatment Area Location at Time of Construction.
- 2.) Engineer Will Inspect the Installation of Pipe, Septic Tank, Etc. Prior to Backfill.
- 3.) Engineer to Inspect the Soil Treatment Area After Backfill to Insure Min. Cover and Proper Drainage Away from Soil Treatment Area.
- 4.) Soil Conditions to be Verified by Soil Engineer at Time of Installation.

NOTES:

All Work per El Paso County Health Department Criteria.

Grade Surrounding Area to Drain Away from Soil Treatment Area.

Maintain 2.0% Min. Grade on Pipe Feeding the Septic Tank, Maintain 2.0% Min, Grade on Pipe Feeding the Soil Treatment Area.

A Vacuum Breaker is Required at the High Point in the Line Between the Pump and the Soil Treatment Area so this Line can Drain to Prevent Freezing.

If the Soil Treatment Area is Located at a Higher Elevation than the Pump, Install a Seepage Collar Around the Pipe to Prevent Back Flow Through the Trench from the Field to the Pump.

Contractor/Homeowner is Responsible for Permit. Contractor/Homeowner Must Obtain Approval of Engineered System from El Paso County Health Department. Contractor/Homeowner Must Verify Setbacks and Obtain Utility Clearances Prior to Construction.

Due to the Possibility of Unknown Water Usage Factors, Geoquest, LLC. Does Not Warranty this Septic System Against Failure or Damage of Any Type.

Paving, Planting of Trees/Shrubs, and Vehicular or Hoofed Animal Traffic of Any Kind Over the Soil Treatment Area may Cause Premature Failure and is Prohibited.

Refer to Sheet 2 & 3 for Details.

GEOQUEST, LLC.


6825 SILVER PONDS HEIGHTS SUITE 101 COLORADO SPRINGS, CO 80908

OFFICE: (719) 481-4560 FAX: (719) 481-9204




Project: 12-0561	Project Name and
Sheet: 1 of 3	
Date: 3 Oct 2012	Tiffany Homes

12840 Blue Spruce Lane Geoguest Perc. Lot #4, Blue Spruce Estates S/D, Drawn by: grr El Paso County, Colorado Checked by: cem

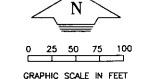

SCALE: 1" = 100"

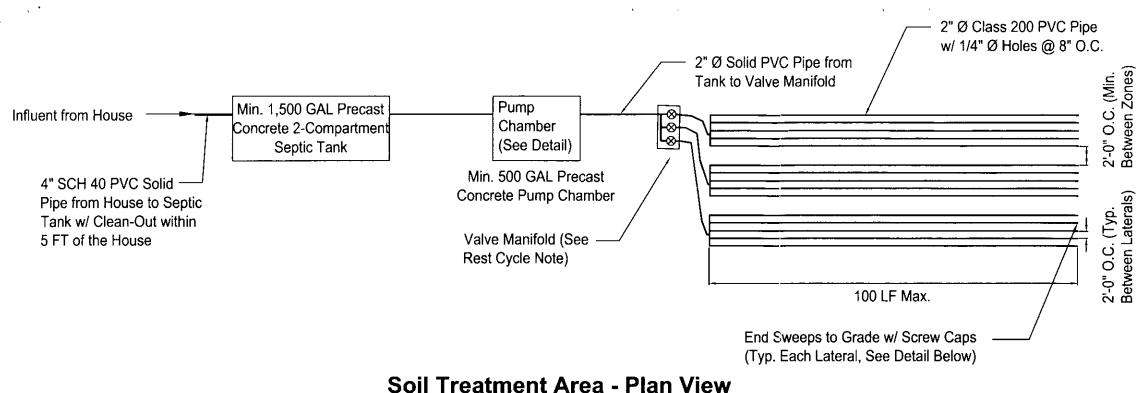

Not to Scale

End Sweeps to Grade w/ Screw Caps at End Opposite Manifold (Typ. -Each Lateral) May be Placed in Small Valve Box if Desired. This Will Provide Access to Flush Each Lateral, Allowing for Removal of the Build-Up of Organics (System Maintenance). See Detail. Native Soil Backfill; Do Not Compact All Laterals within Zone to be Level: Zones May be at Different Elevations. 24" Min 16" Min. No. of Laterals as Required Not to Exceed 1000 SQ. FT per Zone


★ If 8" Width Cannot be Attained, Contact Engineer.

Typical Zone Cross Section

Rest Cycle Note:

Research Indicates Allowing a Septic Field to "Rest" for Several Months Increases Its Long term Utility.

Geoguest, LLC. Recommends Resting Each Zone for Three to Six Months, Systematically Cycling Through Each Zone Sequentially such that Each Zone of the System is Idled for a Period Every One or Two Years.

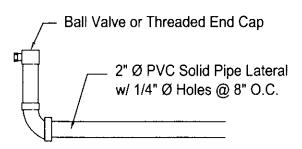

End Sweep to Grade Detail

Not to Scale

Septic Tank and Plumbing Design:

Number of Laterals:

3,000 SF / 200 SF per Lateral = 15 Laterals

(500 LF per Zone)(3 Zones) = 1,500 LF of Pipe

Pump: Use Zoeller "Mighty Mate" 53, Orenco Pl3005 High Head Effluent Pump, or Approved Equivalent; Design Flow Rate = 20.0 GPM

Total Dynamic Head (TDH) = 10.9 ft to Valve Manifold Dose Vol. = 300 Gal. Recommended

Main Septic Tank Size: Min. 1,500 GAL Pump Chamber: Min. 500 GAL

Distribution Pipe: Use 2" Ø Class 200 PVC Field (Zone) Pipe: Use 2" Ø Class 200 PVC 1/4" Ø Holes @ 8" O.C.

Special Note: A Profile Pit Inspection is Required Prior to the Installation of this On-Site Wastewater Treatment System to Evaluate the Structure of the Bedrock Material Encounterd in the Percolation Test Profile.

GEOQUEST, LLC.

6825 SILVER PONDS HEIGHTS **SUITE 101** COLORADO SPRINGS, CO

OFFICE: (719) 481-4560 FAX: (719) 481-9204

Project: 12-0561 Sheet: 2 of 3


Date: 3 Oct 2012 Scale: N.T.S.

80908

Drawn by: grr Checked by: cem Tiffany Homes

12840 Blue Spruce Lane Lot #4, Blue Spruce Estates S/D, El Paso County, Colorado

Project Name and Address

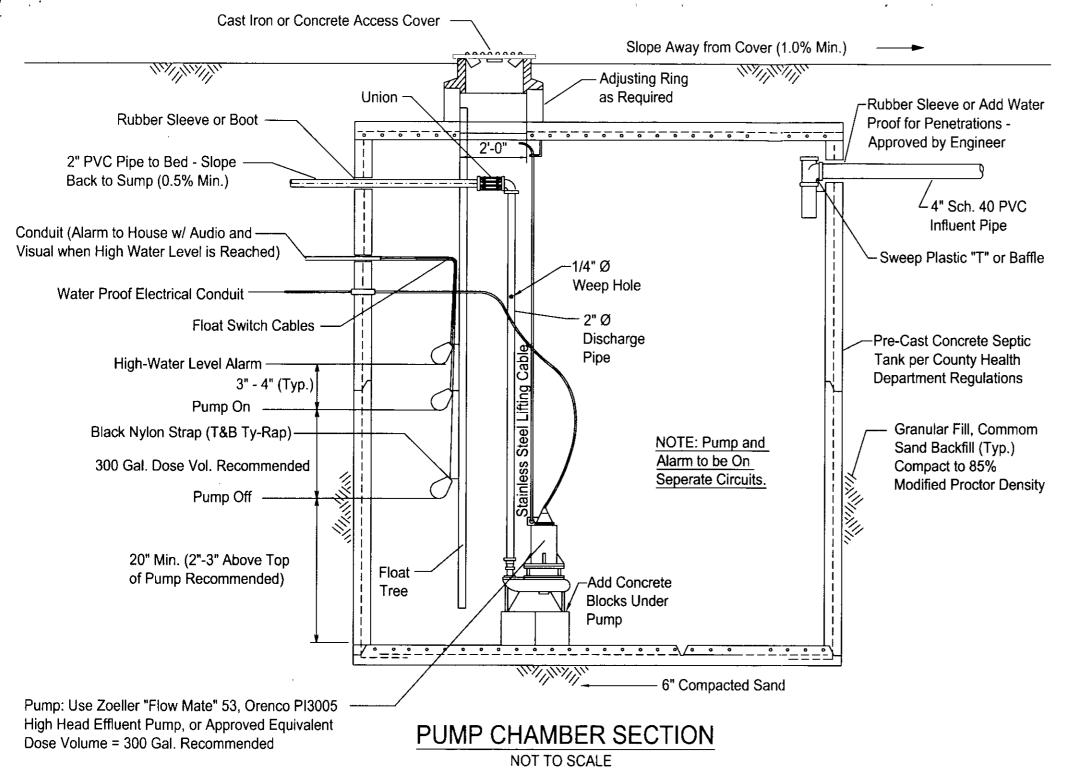

Rest Cycle Note:

Research Indicates Allowing a Septic Field to "Rest" for Several Months Increases Its Long term Utility.

Geoguest, LLC. Recommends Resting Each Zone for Three to Six Months, Systematically Cycling Through Each Zone Sequentially such that Each Zone of the System is Idled for a Period Every One or Two Years.

Electrical Code Requirements: All electrical work, equipment, and material must be listed for the intended use by a nationally recognized testing laboratory, and comply with the requirements of the National Electrical Code in effect on the date of the permit. The electrical installer shall contact the electrical inspector for the location where the ISDS is constructed.

- 1. All wire splices shall be enclosed in a National Electrical Manufacturers Association (NEMA) 4x splice box. The splice box shall be placed in an accessible location positioned outside of the tank riser.
- 2. All wires shall be spliced with silicon seal wire nuts or heat shrink sleeves.
- 3. Conduits shall be sealed to prevent gases from entering the splice box or the control panel (if system is so equipped) and electrical panel.
- 4. A means to disconnect the house power supply to OWTS components shall be provided at the splice box or at the pump control panel (if system is so equipped).
- 5. The branch circuit wire from the building to the splice box shall be a minimum of 24" below the ground surface. Lines buried less than 24" are allowed, but will be required to be in conduit or have ground fault protection on the circuit.
- 6. Conduit risers for physical protection must extend 18" below grade.

Best Practices Guidelines: The following "best practices" are intended to facilitate maintenance and servicing of the electrical components associated with lift stations, dosing systems, and treatment units that are part of an OWTS.


- 1. The "quick disconnect" for the pump discharge pipe shall be located within 6"-12" of the top of the riser(s). Electrical lines at the septic tank, dosing tank, or treatment unit must be placed in such a manner as to protect them from damage during backfill. An example of such protection is placement of the electrical line in an approved conduit.
- 2. The floats shall be secured to a seperate float tree with approved connecting straps that will remain secure underwater and not deteriorate. Electrical tape is not acceptable. Top of float tree to be within 6" - 12" of the top of the lift station, dosing system tank or treatment unit riser.
- 3. If a separate riser is used, it shall be secured to maintain the riser in an upright and plumb position
- 4. Control panels, if used, shall be placed within "line of sight" of the pump.
- 5. The alarm and pump control floats shall be placed on a separate dedicated circuit.
- 6. The pump shall be placed on a separate dedicated circuit.

GEOQUEST, LLC.

6825 SILVER PONDS HEIGHTS **SUITE 101**

COLORADO SPRINGS, CO 80908

OFFICE: (719) 481-4560 FAX: (719) 481-9204

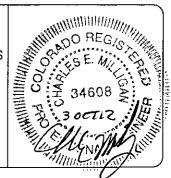

Project:	12-0561
Sheet: 3	of 3

Scale: N.T.S.

Drawn by: grr Checked by: cem Lot #4, Blue Spruce Estates S/D, El Paso County, Colorado

Project Name and Address

Tiffany Homes Date: 3 Oct 2012 12840 Blue Spruce Lane